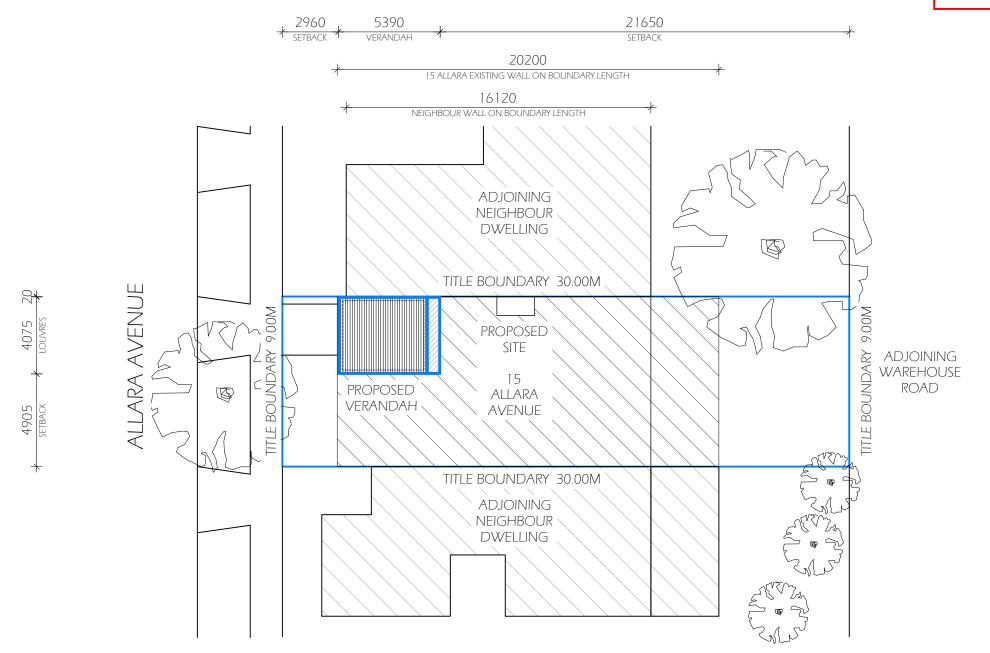
CITY OF MARIBYRNONG ADVERTISED PLAN

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PROPOSED AREA ANALYSIS

270.00m² TOTAL SITE AREA 178.92m² BUILDING AREA (RESIDENCE) VERANDAH 22.07m² SITE COVERAGE (MAX 60%) 178.92m² 66.26% GARDEN AREA (MIN 25%) 75.41m² 27.92% PERMEABILITY (MIN 20%) 75.41m² 27.92% NO CHANGE, BUILD OVER EXISTING BALCONY

NOTE:

- DRAWINGS TO BE READ IN CONJUNCTION WITH CONTRACT
- VERIFY DIMENSIONS ON SITE PRIOR TO THE ORDER OF AND/OR PLACEMENT OF MATERIALS
- CLEARLY VISIBLE 'NO STANDING OR WALKING ON ROOF' SIGN AT A MINIMUM OF TWO POINTS ON THE FINISHED ROOF. OWNERS RESPONSIBILITY TO ENSURE NO ONE WALKS ON THE ROOF WITHOUT THE PROVISION OF TEMPORARY WALKWAYS.
- SMOKE DETECTORS AS PER AS 3786

SITE CONTEXT:














SITE PLAN AND CONTEXT 1:200

NOTE:	LEGEND				SHEET NAME:		SCALE:	ADDRESS:	SHEET NO:
DRAWINGS TO BE READ IN CONJUNCTION WITH CONTRACT	BPOP	BOTTOM POP	D	DOOR	PROJECT: 180F LOUVRES		1:200	15 ALLARA AVENUE	∆ 1 ∩ 1 ≧ p
VERIFY DIMENSIONS ON SITE PRIOR TO THE ORDER OF	RPOP	REAR EXIT POP	Р	POSTS					CLIENT: R. HESLOP
AND/OR PLACEMENT OF MATERIALS	RH	RAIN HEAD	В	BEAM		1		DATE.	
ALL TAGS WITH 'EX' INDICATES EXISTING ON SITE	DP	DOWN PIPE	RP	ROOF POSTS	NORTH:	DRAWN: K.C	CONSULTANT: C. SPARROW	DATE: 27/03/25	
	DPS	SPREADER	RB	RAFTER BRACKETS		CHECKED:	CONTRACT NUMBER:	revision:	Louvre House
	HW	HABITABLE WINDOW	FB	FASCIA BRACKETS	N	M.E	6432D	NE VISICIA.	LOOVICTIOOSC

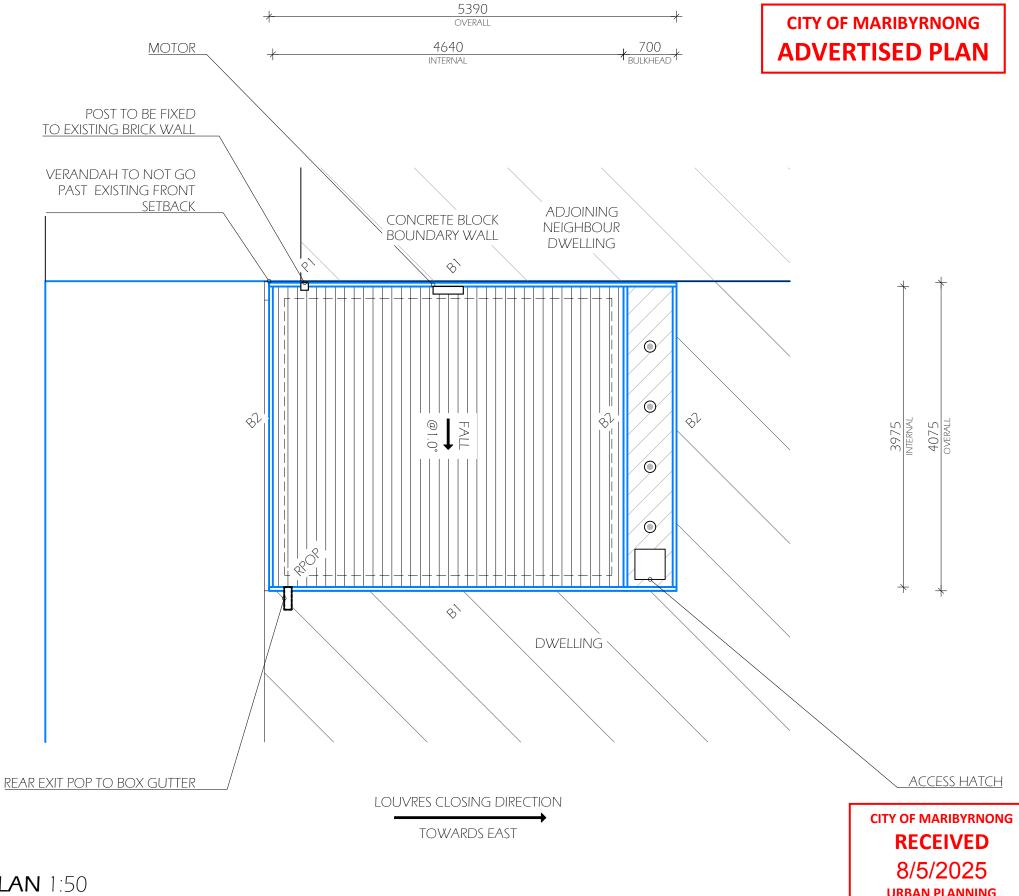

ADJUSTABLE LOUVRES:

NEW OPENING FITTED WITH LOUVRE HOUSE EXTRUDED ALUMINIUM '180F' REMOTELY OPERABLE EXTRUDED ALUMINIUM OPENING LOUVRES. ALL TO FALL @1.0° TO SOUTH (TOWARDS THE HOUSE); ALL TO CLOSE TO EAST (AS INDICATED). POWDERCOAT FINISH; COLOUR SHALL BE 'SURFMIST'.

VERANDAH BEAMS (B1-2):

300X50X3.0MM LOUVRE HOUSE ALUMINIUM RHS VERANDAH BEAMS TO INNER PERIMETER OF NEW FRAMES TYPICALLY. 2X CUSTOM END CAPS TO ALL BEAMS. PROFILE, FINISH AND COLOUR TO MATCH. POWDERCOAT FINISH; RENDER COLOUR SHALL BE 'WINDSPRAY'. REFER DETAIL

VERANDAH POST (P1):

100X100X3.0MM LOUVRE HOUSE ALUMINIUM SHS VERANDAH POST AS INDICATED. P1 TO BE FIXED TO BRICK WALL WITH SUITABLE ANCHOR. FACE OF POSTS FLUSH WITH OUTSIDE OF BEAMS. CONTRACTOR TO VERIFY ADEQUACY OF SAME. POWDERCOAT FINISH; COLOUR SHALL BE 'WINDSPRAY'

INTERNAL GUTTERS:

155MM (NOM.) WIDE LOUVRE HOUSE INTERNAL GUTTERS TO INSIDE OF FRAME ALL ROUND. MITRED AT CORNERS AND COVERED WITH CUSTOM GALV. STEEL GUTTER STRIPS. POWDERCOAT FINISH; COLOUR SHALL BE 'SURFMIST'.

STORMWATER:

REAR EXIT POP TO DISCHARGE TO EXISTING BOX GUTTER DRAINAGE.

ELECTRICAL (0):

LAYOUT INDICATIVE ONLY.

4 RECESSED DOWN LIGHTS BY LOUVRE
HOUSE.

FINAL LOCATION OF DOWNLIGHTS AT DIRECTION OF SITE SUPERVISOR IN CONSULTATION WITH OWNER.

1 GPO & CONNECTION OF MOTOR BY


LH/OWNER.

MATERIAL:
ALL MATERIALS U.N.O ARE POWDER
COATED ALUMINIUM PRODUCTS FOR
PROTECTION OF CORROSION AND NON
COMBUSTIBILITY.

FLOOR / ROOF PLAN 1:50

NOTE:	LEGEND			
DRAWINGS TO BE READ IN CONJUNCTION WITH CONTRACT	BPOP	BOTTOM POP	D	DOOR
VERIFY DIMENSIONS ON SITE PRIOR TO THE ORDER OF	RPOP	REAR EXIT POP	Р	POSTS
AND/OR PLACEMENT OF MATERIALS	RH	RAIN HEAD	В	BEAM
ALL TAGS WITH 'EX' INDICATES EXISTING ON SITE	DP	DOWN PIPE	RP	ROOF POSTS
ALE INGS WITH EX INDIG (IES EXISTING ON SITE	DPS	SPREADER	RB	RAFTER BRACKETS
	HW	HABITABLE WINDOW	FB	FASCIA BRACKETS

		ORBAN PL	ANNING		
SHEET NAME: FLOOR / ROOF PLAN		SCALE: 1:50	ADDRESS: 15 ALLARA AVENUE	SHEET NO: A 102	ORIGINAL: A3
PROJECT: 180F LOUVRE	S	CLIENT: R. HESLOP	MARIBYRNONG 3032	A102	
NORTH:	DRAWN: K.C	CONSULTANT: C. SPARROW	DATE: 27/03/25		
	CHECKED: M.E	CONTRACT NUMBER: 6432D	REVISION:	Louvre Hous	se

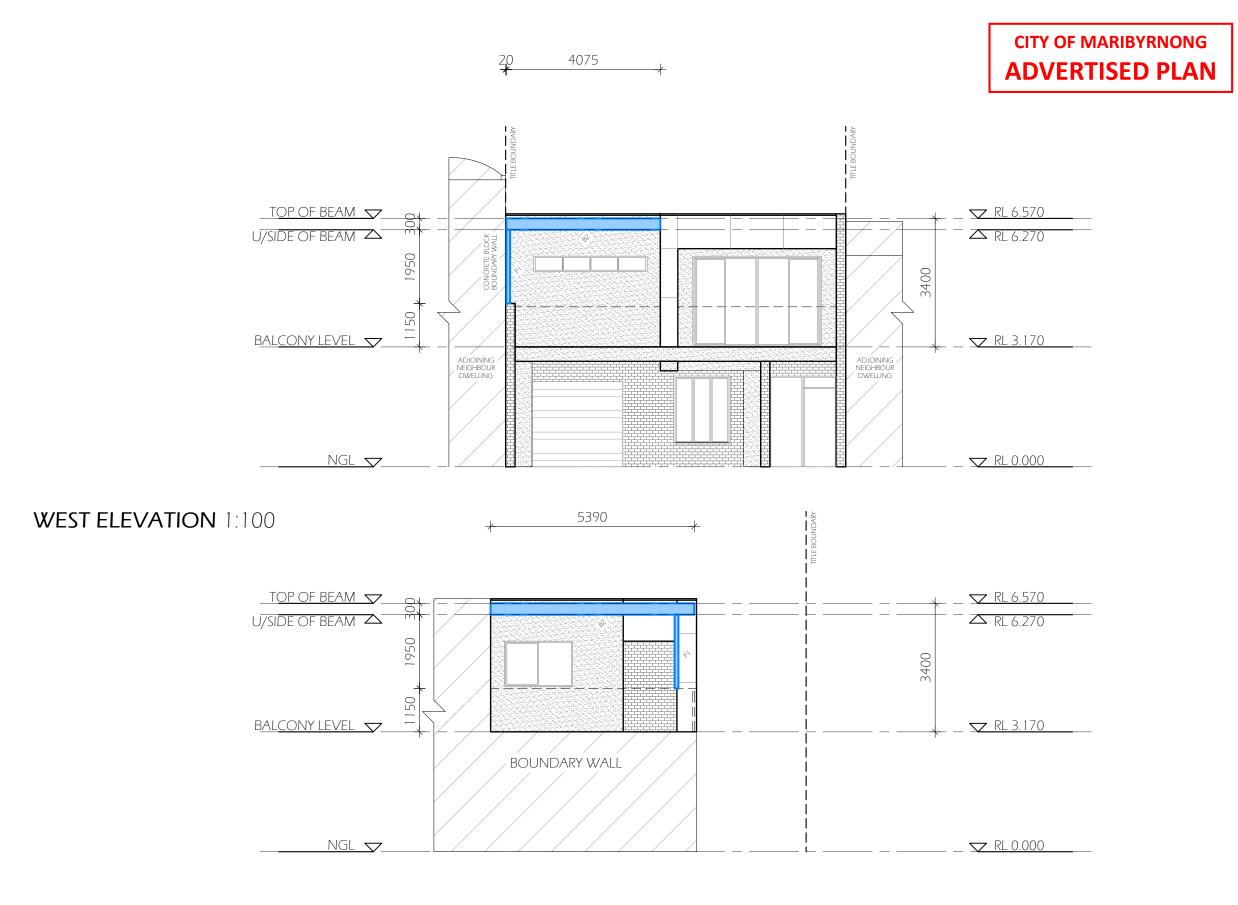


COLOUR SCHEDULE: CO1 - COLORBOND WINDSPRAY TO TOP FLASHING, BEAMS, POSTS, RAIN HEAD AND DOWNPIPES CO2 - COLORBOND SURFMIST TO LOUVRES, INSIDE FLASHING AND GUTTERS

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NORTH ELEVATION 1:100

NOTE:	LEGEND				SHEET NAME		SCALE:	ADDRESS:	SHEET NO:	
DRAWINGS TO BE READ IN CONJUNCTION WITH CONTRACT	BPOP	BOTTOM POP	D	DOOR	ELEVATIONS		1:100	15 ALLARA AVENUE	Δ1Λ3 🚉 🤊	
VERIFY DIMENSIONS ON SITE PRIOR TO THE ORDER OF	RPOP	REAR EXIT POP	Р	POSTS	PROJECT: 180F LOUVRES		CLIENT: R. HESLOP	MARIBYRNONG 3032		
AND/OR PLACEMENT OF MATERIALS	RH	RAIN HEAD	В	BEAM				DATE.		
ALL TAGS WITH 'EX' INDICATES EXISTING ON SITE	DP	DOWN PIPE	RP	ROOF POSTS	NORTH:	DRAWN: K.C	CONSULTANT: C. SPARROW	DATE: 27/03/25		
	DPS	SPREADER	RB	RAFTER BRACKETS		CHECKED: M.E	CONTRACT NUMBER:	REVISION:	Louvre House	
	HW	HABITABLE WINDOW	FB	FASCIA BRACKETS			6432D			



FLASHING:

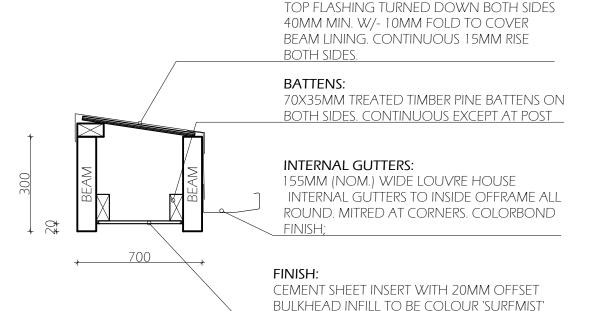CITY OF MARIBYRNONG
ADVERTISED PLAN


RECEIVED


8/5/2025
URBAN PLANNING

BEAM SCHEDULE

B 300X50X3MM LOUVRE HOUSE ALUMINIUM RHS VERANDAH BEAMS AFFIXED TO EXISTING WALL WITH SUITABLE ANCHORS, STAGGERED @ 600 C/C MAX.

BULKHEAD DETAIL1:10

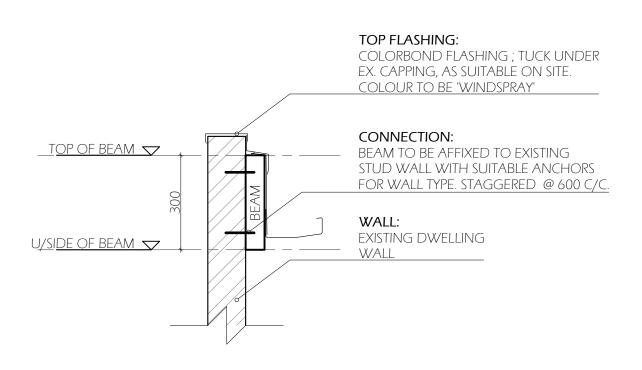


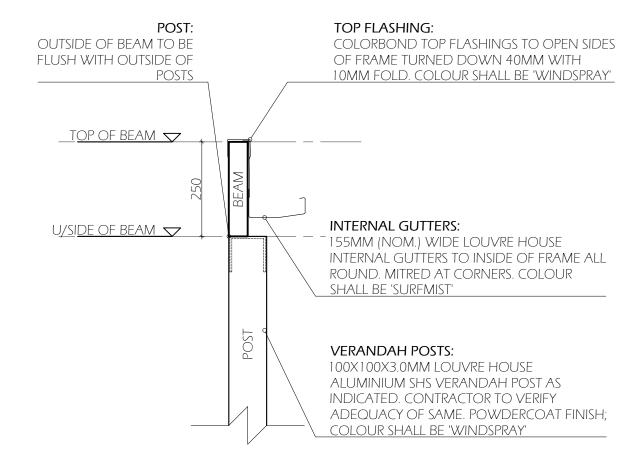


BEAM CONNECTION EX WALL 1:10

POST - BEAM JUNCTION DETAIL 1:10

NOTE:	LEGEND				SHEET NAME	:	SCALE:	ADDRESS:	SHEET NO:	
DRAWINGS TO BE READ IN CONJUNCTION WITH CONTRACT	BPOP	BOTTOM POP	D	DOOR	DETAILS		1:10	15 ALLARA AVENUE	A 104	
VERIFY DIMENSIONS ON SITE PRIOR TO THE ORDER OF	RPOP	REAR EXIT POP	Р	POSTS	PROJECT: 180F LOUVR	FS	CLIENT: R. HESLOP	MARIBYRNONG 3032	A10 1	ORIG
AND/OR PLACEMENT OF MATERIALS	RH	RAIN HEAD	В	BEAM				DATE		
ALL TAGS WITH 'EX' INDICATES EXISTING ON SITE	DP	DOWN PIPE	RP	ROOF POSTS	NORTH:	DRAWN: K.C	CONSULTANT: C. SPARROW	DATE: 27/03/25		
	DPS	SPREADER	RB	RAFTER BRACKETS		CHECKED:	CONTRACT NUMBER:	revision:	Louvre Ho	LISE
	HW	HABITABLE WINDOW	FB	FASCIA BRACKETS		M.E	6432D	INE VISIOI V.	LOOVICTIOUSC	

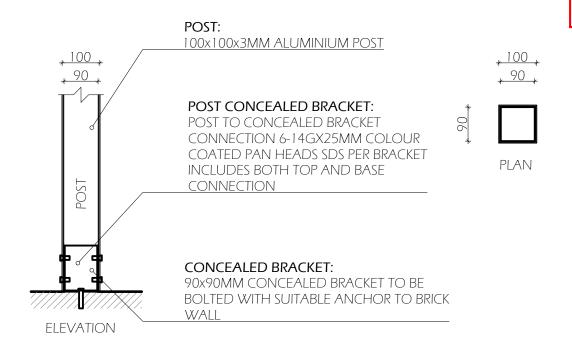


POST-BASE JUNCTION DETAIL 1:10

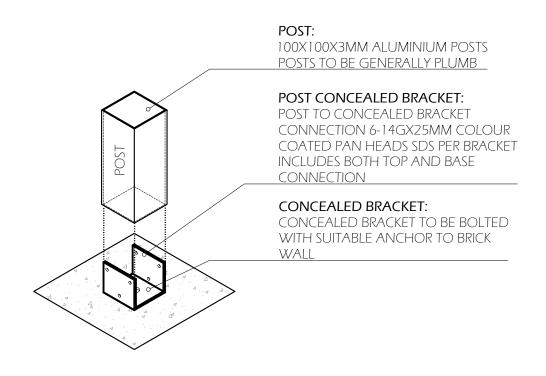

CITY OF MARIBYRNONG ADVERTISED PLAN

CLEARANCE:
A CLEARANCE OF 100-150MM IS
REQUIRED FROM SIDE BEAM

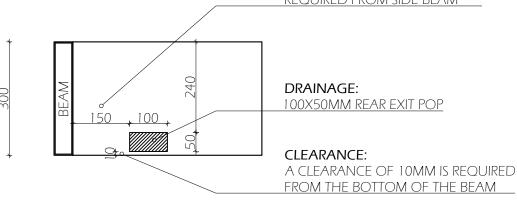

REAR EXIT POP DETAIL1:10

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URBAN PLANNING

BEAM CONNECTION:

END CAP CONNECTION MIN 6-14Gx25MM COLOUR COATED PAN HEADS SDS PER BEAM

BEAM:

BEAM TO BE 250x50x3MM ALUMINIUM MAX SPAN 6000MM TO BE INSTALLED GENERALLY LEVEL

CONCEALED BRACKET:

CONCEALED POST CONNECT TO BEAMS WITH MIN 6-14Gx25MM COLOUR COATED PAN HEADS SDS PER BEAM

POST CONCEALED BRACKET:

POST TO CONCEALED BRACKET CONNECTION 6-14Gx25MM COLOUR COATED PAN HEADS SDS PER BRACKET INCLUDES BOTH TOP AND BASE CONNECTION

POST:

POSTS TO BE GENERALLY PLUMB

BOTTOM CONCEALED BRACKETS CONNECTION DETAIL 1:10

TOP CONCEALED BRACKETS CONNECTION DETAIL 1:10

NOTE:	<u>LEGEND</u>				SHEET NAM	=: =:	SCALE:	ADDRESS:	SHEET NO:	J .:
DRAWINGS TO BE READ IN CONJUNCTION WITH CONTRACT	BPOP	BOTTOM POP	D	DOOR	DETAILS		1:10	15 ALLARA AVENUE	A105	ORIGIN/ A3
VERIFY DIMENSIONS ON SITE PRIOR TO THE ORDER OF	RPOP	REAR EXIT POP	Р	PROJECT: 180F LOUVRES		?FS	CLIENT: R. HESLOP	MARIBYRNONG 3032	7105	
AND/OR PLACEMENT OF MATERIALS	RH	RAIN HEAD	В	BEAM				DATE		
ALL TAGS WITH 'EX' INDICATES EXISTING ON SITE	DP	DOWN PIPE	RP	ROOF POSTS	NORTH:	DRAWN: K.C	CONSULTANT: C. SPARROW	DATE: 27/03/25		
	DPS	SPREADER	RB	RAFTER BRACKETS		CHECKED:	CONTRACT NUMBER:	REVISION:	Louvre Hou	ISP
	HW	HABITABLE WINDOW	FB	FASCIA BRACKETS		M.E	6432D	INE VISIOIN.	LOUVIETIOUSE	