NOTES REFLECTED CEILING

Exit Signs & Emergency Lights to Comply with A.S. 2293' Artificial Lighting to Comply with A.S. 1680

Moisture Resistant Plasterboard to all Wet Areas.

Refer to Electrical, Mechanicla & Hydraulic Services Drawings for all Services Details.

Provide Access Panels for Mechanical & Electrical Services to Plasterboard Ceilings, Refer to Service Engineers Drawings for Requirements.

Provide Square Set Cornice to all Flush Plasterboard Ceiling Wall & Column Junctions.

Shadowline or Longleg Wall Angles to all Wall Column Junctions.

Suspension System to be Installed in Accordance with Manufacturer's Specification with the Spans of the Main & Cross Tees not Exceeding Their Design Requirements.

All Tenancy Walls to Amenities & Foyer Including Tenancy Dividing Walls to be to Underside of Floor Slab or Roof Structure Over with Insulation & Acoustic as Specified. (Provide Deflection Head).

Dry Wall Systems including Control Joints (Expansion Joints) Shall be Complete Proprietary Systems. In Accordance with Product Data & the Relevant Standards. Construct Control Joints to Plasterboard Sheeting Using a Suitable Proprietary System, Rondo or Similar, Approved Install Stopping Bends Both Sides & Required Joint Fillers & Inserts, Control Joints in Finished Work Shall Extend Full Depth to Base Building & Substrates & Shall Coincide With Joints in Base Building & Substrates.

For Conctrol Joint Location & Frequency Refer to Product Manufacturer's Recommendations Typically for Internal Walls With Plasterboard Outer Layer, 12m Maximum Centres @ Junctions with Other Building Elements: at Changes of Lining Material, at Changes of Structural Support Systems, at each Storey or Rise of Studs.



Drawing Register:

WKG DWG A01 1:200 SITE PLAN WKG DWG A02 1:100 **EXISTING FLOOR PLAN** WKG DWG A03 1:100 **PLANS** WKG DWG A04 1:100 SECTION A-A WKG DWG A05 NTS NOTES WKG DWG A06 NTS **GENERAL NOTES**

These Drawings are to be Read in Conjunction With & are Subject to the Terms of Dees Designs Agreement, Including its Scope of Services Required Under That Agreement. These Drawings Have Been Prepared Using Reasonable Skill, Care & Diligence That Would Ordinarily be Provided by an Architectural Draftsperson. Nothing Provided by Dees Designs Will Relieve any Third Party (including the Builder) FromAny Responsibility and Liability.

The Builder Must Confirm All Dimensions on Site Prior to the Commencement of any Part of the Works. Do Not Scale Off Drawings - Use Figured Dimensions only.

These Drawings are Non-Exhaustive, May Not be Final & are Subject to Applicable Development, Alteration & Change & Musst be Read in Conjunction With the Relevant Terms & Conditions of Dees Designs Agreement & the other Relevant Project Specifications, Drawings & Schedules.

If any Error, Ambiguity, Discrepancy or Inconsistency is Discovered, such Error, Ambibuity, Discpreancy or Inconsistency Must be Identified to Dees Designs & the Buildinger Promptly.

The Drawings Provided by Dees Designs are Intended for its Client Only & are not to be Relied Upon by any Other Third Party

Building Permit Application for Internal Fitout Factory Equipment to Existing Tilt Panel Building with Mezzanine

Αt

Unit 12 380 Somerville Road West Footscray

For: Mr Hernan Pavez

BUILDING PERMIT APPLICATION TO COMPLY WITH LOCAL COUNCIL BCA NCC 2022 RELEVANT AUSTRALIAN STANDARDS

DATE: MAY 2025

AMENDED ARCHITECTURAL DRAWINGS 17 AUGUST 2025

Rev Description Date	Drn	This drawing remains the property of Dees Designs No copying without the permission of Architect/Designer	Site Address:	Project Title:	Drawing Title:	Drawing Number:	Site Orientation:	DEE'S DESIGNS
1. 1. Show site dimensions title brs 17/08/2025 2. show built form surrounding site		Do not scale drawings check all dimensions on site prior to commencement	Unit 12 380 Somerville Road	Internal Fitout for Factory	TITLE PAGE			ddneville DP/AD1431 Bachelor of Architecture
3. show existing plan		of construction.	West Footscray					71 Hansen Street West Footscray 3012
and proposeed			Cliente		Scale:	-		phone 0416162526
4. locate car spaces for unit 12 5. show note re rear courtyard space			Mr Pavez					email: ddneville3012@hotmail.com
5. Show hote relear courtyard space		NOT FOR CONSTRUCTION			1/05/2025	Paper size:	Registration No. DP/AD 1431	





Rev Description

1. 1. Show site dimensions title brs

2. show built form surrounding site

3. show existing plan

and proposeed

4. locate car spaces for unit 12

5. show note re rear courtyard space

Date

Drn


This drawing remains the property of Dees Designs
No copying without the permission of Architect/Designer
Do not scale drawings check all
dimensions on site prior to commencement
of construction.

Unit 12
380 Somerville Road
West Footscray

Clients:
Mr Pavez

Project Title:
Internal Fitout of Existing
Tilt Panel Building with
Mezzanine for Factory

DEE'S DESIGNS
ddneville DP/AD1431
Bachelor of Architecture
71 Hansen Street
West Footscray 3012
phone 0416162526
email: ddneville3012@hotmail.com

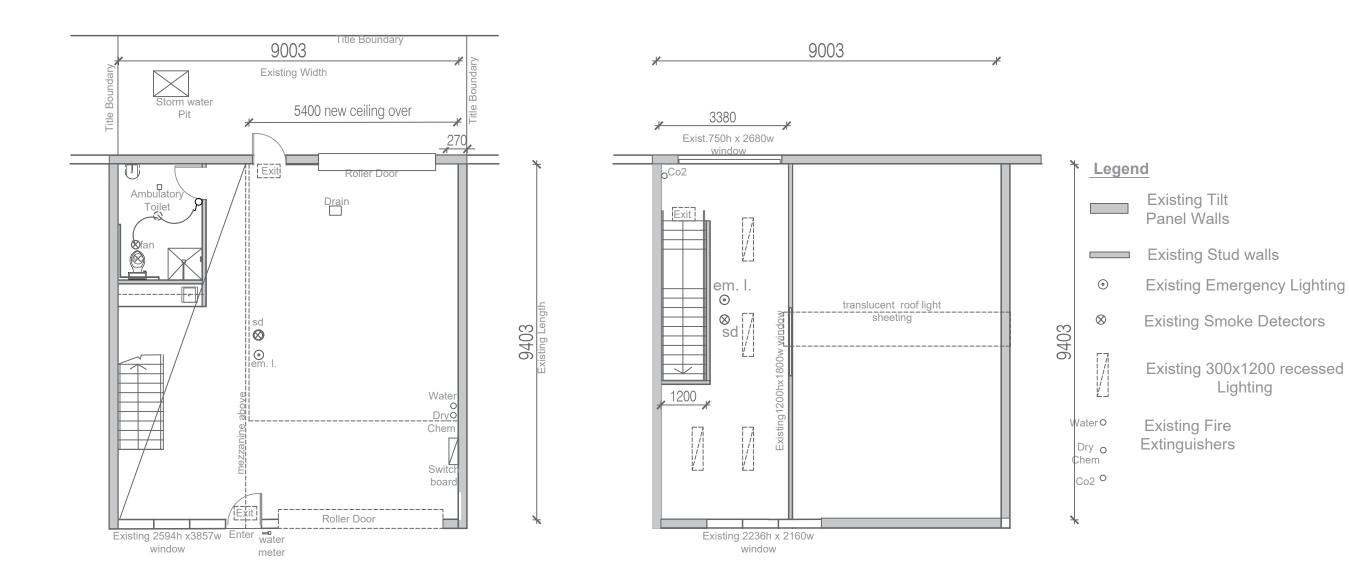


EXISTING FLOOR PLAN

EXISTING Mezzanine Floor

Rev Description D 1. 1. Show site dimensions title brs 1 2. show built form surrounding site 3. show existing plan and proposeed 4. locate car spaces for unit 12 5. show note re rear courtyard space	ate Dm 7/08/2025	(C) This drawing remains the property of Dees Designs No copying without the permission of Architect/Designer Do not scale drawings check all dimensions on site prior to commencement of construction.	Site Address: Unit 12 380 Somerville Roa West Footscray Clents: Mr Pavez	Internal Fitout of Existing Tilt Panel Building with Mezzanine for Factory	EXISTING PLANS Scale: 1:100	AO2	Site Orientation:	DEE'S DESIGNS ddneville DPIAD1431 Bachelor of Architecture 71 Hansen Street West Footscray 3012 phone 0416162526 email: ddneville3012@hotmail.com
e. orion necessorical occurryard opace		NOT FOR CONSTRUCTION			^{Date} 2/05/2025	Paper size: A3	DP/AD 1431	

Back area to be for bin storage

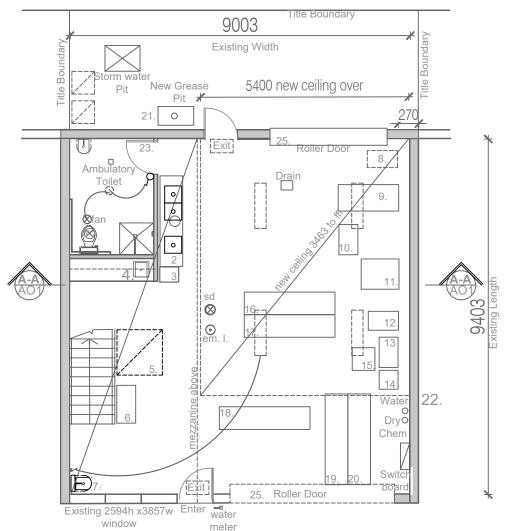


New Fitting Legend

- 1. New Basin Handwash
- 2. New Bench double Sink & Hand Wash Basin
- 3. Pot washer
- 4. Existing Sink
- 5. Refridgerator
- 6. Cupboard
- 7. New Handwash basin
- 8. Compressor
- 9. Bench
- 10. Dough Container
- 11. Vainera Machine
- 12. Mixer Machine
- 13. Filler Machine
- 14. Chair
- 15. Bench (Filler)
- 16. Bench (decoration)
- 17. Bench (decoration)
- 18. Storage Shelf
- 19. Storage Shelf
- 20. Storage Shelf
- 21. New Gease Trap?
- 22. Move Hydrants south 1m
- 23. Self Closing Door to Toilet
- 24. Fan to Operate on Light switch
- 25. Roller Doors to be Closed at all Times

NOTE: All new
Basins/Sinks to be
connected to existing
Plumbing water supply &
drain to legal point of
discharge


These Drawings are to be Read in Conjunction With & are Subject to the Terms of Dees Designs Agreement, Including its Scope of Services Required Under That Agreement. These Drawings Have Been Prepared Using Reasonable Skill, Care & Diligence That Would Ordinarily be Provided by an Architectural Draftsperson. Nothing Provided by Dees Designs Will Relieve any Third Party (including the Builder) FromAny Responsibility and Liability.

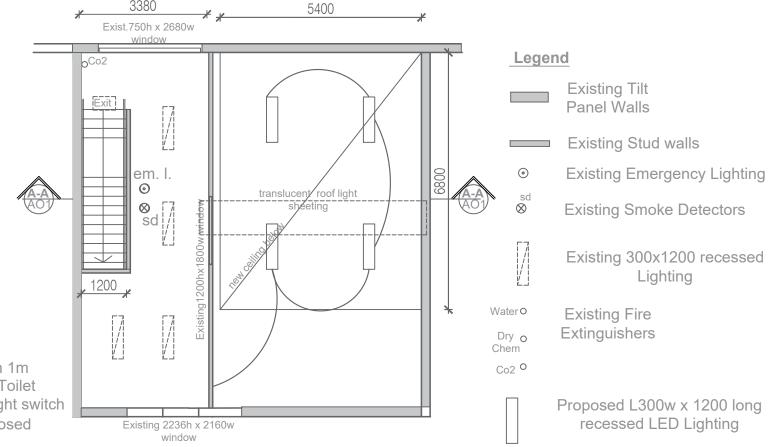

FLOOR PLAN

MEZZANINE FLOOR

1.	Description 1. Show site dimensions title brs 2. show built form surrounding site 3. show existing plan and proposeed 4. locate car spaces for unit 12	Date Drn 17/08/2025	© This drawing remains the property of Dees Designs No copying without the permission of Architect/Designer Do not scale drawings check all dimensions on site prior to commencement of construction.	Unit 12 380 Somerville Roawest Footscray	Internal Fitout of Existing Tilt Panel Building with Mezzanine for Factory	Drawing Title: FLOOR PLAN Scale:	AO3	Site Orientation:	DEE'S DESIGNS ddneville DP/AD1431 Bachelor of Architecture 71 Hansen Street West Footscray 3012 phone 0416162526 email: ddneville3012@hotmail.com
	5. show note re rear courtyard space			Mr Pavez		1:100	Paper size:	Registration No.	- Cindii: danoviiiooo12@noandii.com
			NOT FOR CONSTRUCTION			1/05/2025	A3	DP/AD 1431	

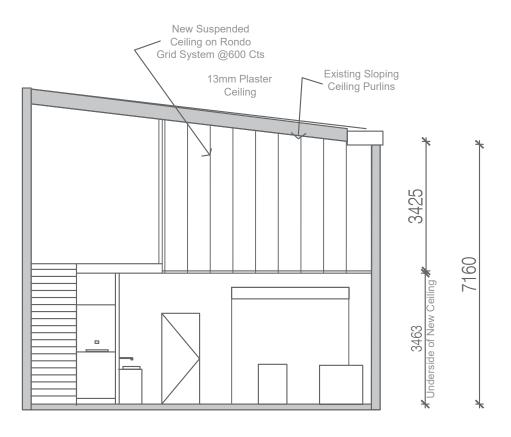

SECTION A-A

This drawing remains the property of Dees Designs No copying without the permission of Architect/Designer Drawing Title: Description Date DEE'S DESIGNS **SECTION A-A** 17/08/2025 ddneville DP/AD1431 Bachelor of Architecture 1. Show site dimensions title brs Unit 12 **Internal Fitout of Existing** Do not scale drawings check all dimensions on site prior to commencement 380 Somerville Road Tilt Panel Building with 2. show built form surrounding site **AO4** 71 Hansen Street West Footscray 3012 3. show existing plan of construction West Footscray Mezzanine for Factory and proposeed phone 0416162526 email: ddneville3012@hotmail.com 4. locate car spaces for unit 12 1:100 **Mr Pavez** 5. show note re rear courtvard space NOT FOR CONSTRUCTION 2/05/2025 A3 DP/AD 1431

NOTES REFLECTED CEILING

Exit Signs & Emergency Lights to Comply with A.S. 2293' Artificial Lighting to Comply with A.S. 1680

Moisture Resistant Plasterboard to all Wet Areas.

Refer to Electrical, Mechanicla & Hydraulic Services Drawings for all Services Details.

Provide Access Panels for Mechanical & Electrical Services to Plasterboard Ceilings, Refer to Service Engineers Drawings for Requirements.

Provide Square Set Cornice to all Flush Plasterboard Ceiling Wall & Column Junctions.

Shadowline or Longleg Wall Angles to all Wall Column Junctions.

Suspension System to be Installed in Accordance with Manufacturer's Specification with the Spans of the Main & Cross Tees not Exceeding Their Design Requirements.

All Tenancy Walls to Amenities & Foyer Including Tenancy Dividing Walls to be to Underside of Floor Slab or Roof Structure Over with Insulation & Acoustic as Specified. (Provide Deflection Head).

Dry Wall Systems including Control Joints (Expansion Joints) Shall be Complete Proprietary Systems. In Accordance with Product Data & the Relevant Standards. Construct Control Joints to Plasterboard Sheeting Using a Suitable Proprietary System, Rondo or Similar, Approved Install Stopping Bends Both Sides & Required Joint Fillers & Inserts, Control Joints in Finished Work Shall Extend Full Depth to Base Building & Substrates & Shall Coincide With Joints in Base Building & Substrates.

For Conctrol Joint Location & Frequency Refer to Product Manufacturer's Recommendations Typically for Internal Walls With Plasterboard Outer Layer, 12m Maximum Centres @ Junctions with Other Building Elements: at Changes of Lining Material, at Changes of Structural Support Systems, at each Storey or Rise of Studs.

GENERAL NOTES

Builder to Confirm all Dimensions on Site Prior to Commencement of Any Part of the Works.

All Drawings are to be Read in Conjunction with The Specification & Schedules.

Consult Dees Designs on any Discrpeancies Prior to Commencement of any Part of the Works.

Fire Indicies of Materials, Linings & Surfaces to Comply with Specs C of the BCA.

Electrical Switchboard Located in the Path of Travel & Exists to be Enclosed in Metal, or Other Incombustible Cabinet with Smoke Proof Doors.

Neatly Fill Penetrations to Electrical Wiring Through Electrical Switchboards.

Non Slip Finishes to be Provided to All Steps, Ramps, Landings & Wet Areas.

Fire Hose & Hydrant Installations to Comply With AS-2441 & AS-2418

Thresholds at External Doors According to BCA are not Required to be Accessible & are not to Exceed 190mm above Finished Surfaces.

All Other Doors to Have Thresholds Alighned With the Finished Floor Surface or to be Provided With a Threshold Ramp &/or Landing with a Step Ramp to AS-1428.

Portable Fire Extinguishers to Comply with AS-2444, Provide (E) Dry Chemical Fire Extinguisher Adjacent to Each.

Provide Waterproof Tanking or 'Xypex' or Similar Additive to all Concrete Panels Below Ground Level.

All External Steelwork is to be Hot Dipped Galvanised All Internal Steelwork is to be Shop Primed.

Exit Signs & Emergency Lighting to Comply with AS-2293

Mechanical Ventilation to be Provided to AS-1668-2

EXITS

All Exit Doors & Doors in the Path of Travel to Exits are to be Capable of Being Opened at all Times From the Side Facing a Person Seeking Egress from the Building with a Single Handed Downward or Pushing Action on a Single Device Without the use of a Key & Located Between 500 & 1100 above Floor Level in Accordance with the BCA.

DISABALED ACCESS

If Electronic Door Strikes or the Like are Proposed to be Fitted Within the Building (e.g., for Security Purposes), Those Strikes in Addition to Being Fail Safe are Required to be Connected to the FIP in a Manner so They Become Disarmed/Deactivated Upon FIP Alarm.

SLIDING DOORS

Disabled Access to Comply With AS-1428

WATERPROOFING TO WET AREAS

All Waterproofing Including Impervious Finishes in Accordance with AS-3743 to be Provided for all Wet Areas Refer Drawings for Extent.

PENETRATIONS IN FIRE RATED STRUCTURES

Services Openings Penetrations Through (Fire Rated Walls & Floors) Shall be Filled with Fire Rated Sealants Or Equal to Same Fire Rating as the Parent Wall.

STAIRS

Provide Contrasting Color Non Slip Nosing to all Sair Treads.

BRAILLE & TACTILE SIGNS

Braille & Tactile Sign Specification, Luminance-Contrast & Braille to Comply with the BCA & AS-1428.

BRAILLE & TACTILE SIGNS

Braille & Tactile Sign Specification, Luminance-Contrast & Braille to Comply with the BCA & AS-1428.

HEIGHT OF DOOR HANDLES SWITCHES & GPO'S

All Door Handles 1000mm - unless notified otherwise

All Light Switches 1000mm - unless notified otherwise

Switches & GPO's & all Operative Services Points to be Set min 500mm from Internal Wall Corners.

FIRE DOORS

Fire Doors are to be Fitted with Self-Closing Devices Fire Doors are to be Fitted with Signage (20mm High) to BCA Requirements in Contrasting Colour.

> Fire Safe Door DO NOT OBSTRUCT DO NOT KEEP OPEN

VISUAL INDICATORS ON GLAZING

Where there is no Chair Rail, Handrail or Transom, all frameless or fully Glazed Doors, Sidelights, Including any Glazing Capable of Being Mistaken for a Doorway or Opening, Refer AS-1288 Clause 5.4.1, Provide Visual Indicators on Glass AS Per AS-1428 1 Clause 6.8

Rev	Description	Date Di	No copying without the permission of Architect/Designer Do not scale drawings check all dimensions on site prior to commencement of construction.	380 Somerville Road Tilt F	rnal Fitout of Existing	Drawing Title: GENERAL NOTES Scale: NTS	AO5	Site Orientation:	DEE'S DESIGNS ddneville DP/AD1431 Bachelor of Architecture 71 Hansen Street West Footscray 3012 phone 0416162526 email: ddneville3012@hotmail.com
			NOT FOR CONSTRUCTION			12/05/2025	Paper size:	DP/AD 1431	

GENERAL NOTES

Builder to Confirm all Dimensions on Site Prior to Commencement of Any Part of the Works.

All Drawings are to be Read in Conjunction with The Specification & Schedules.

Consult Dees Designs on any Discrpeancies Prior to Commencement of any Part of the Works.

Fire Indicies of Materials, Linings & Surfaces to Comply with Specs C of the BCA.

Electrical Switchboard Located in the Path of Travel & Exists to be Enclosed in Metal, or Other Incombustible Cabinet with Smoke Proof Doors.

Neatly Fill Penetrations to Electrical Wiring Through Electrical Switchboards.

Non Slip Finishes to be Provided to All Steps, Ramps, Landings & Wet Areas.

Fire Hose & Hydrant Installations to Comply With AS-2441 & AS-2418

Thresholds at External Doors According to BCA are not Required to be Accessible & are not to Exceed 190mm above Finished Surfaces.

All Other Doors to Have Thresholds Alighned With the Finished Floor Surface or to be Provided With a Threshold Ramp &/or Landing with a Step Ramp to AS-1428.

Portable Fire Extinguishers to Comply with AS-2444, Provide (E) Dry Chemical Fire Extinguisher Adjacent to Each.

Provide Waterproof Tanking or 'Xypex' or Similar Additive to all Concrete Panels Below Ground Level.

All External Steelwork is to be Hot Dipped Galvanised All Internal Steelwork is to be Shop Primed.

Exit Signs & Emergency Lighting to Comply with AS-2293

Mechanical Ventilation to be Provided to AS-1668-2

EXITS

All Exit Doors & Doors in the Path of Travel to Exits are to be Capable of Being Opened at all Times From the Side Facing a Person Seeking Egress from the Building with a Single Handed Downward or Pushing Action on a Single Device Without the use of a Key & Located Between 500 & 1100 above Floor Level in Accordance with the BCA.

DISABALED ACCESS

If Electronic Door Strikes or the Like are Proposed to be Fitted Within the Building (e.g., for Security Purposes), Those Strikes in Addition to Being Fail Safe are Required to be Connected to the FIP in a Manner so They Become Disarmed/Deactivated Upon FIP Alarm.

SLIDING DOORS

Disabled Access to Comply With AS-1428

WATERPROOFING TO WET AREAS

All Waterproofing Including Impervious Finishes in Accordance with AS-3743 to be Provided for all Wet Areas Refer Drawings for Extent.

PENETRATIONS IN FIRE RATED STRUCTURES

Services Openings Penetrations Through (Fire Rated Walls & Floors) Shall be Filled with Fire Rated Sealants Or Equal to Same Fire Rating as the Parent Wall.

STAIRS

Provide Contrasting Color Non Slip Nosing to all Sair Treads.

BRAILLE & TACTILE SIGNS

Braille & Tactile Sign Specification, Luminance-Contrast & Braille to Comply with the BCA & AS-1428.

BRAILLE & TACTILE SIGNS

Braille & Tactile Sign Specification, Luminance-Contrast & Braille to Comply with the BCA & AS-1428.

HEIGHT OF DOOR HANDLES SWITCHES & GPO'S

All Door Handles 1000mm - unless notified otherwise

All Light Switches 1000mm - unless notified otherwise

Switches & GPO's & all Operative Services Points to be Set min 500mm from Internal Wall Corners.

FIRE DOORS

Fire Doors are to be Fitted with Self-Closing Devices Fire Doors are to be Fitted with Signage (20mm High) to BCA Requirements in Contrasting Colour.

> Fire Safe Door DO NOT OBSTRUCT DO NOT KEEP OPEN

VISUAL INDICATORS ON GLAZING

Where there is no Chair Rail, Handrail or Transom, all frameless or fully Glazed Doors, Sidelights, Including any Glazing Capable of Being Mistaken for a Doorway or Opening, Refer AS-1288 Clause 5.4.1, Provide Visual Indicators on Glass AS Per AS-1428 1 Clause 6.8

Rev Description Date Drn 1. Show site dimensions title brs 17/08/2025 2. show built form surrounding site 3. show existing plan and proposeed 4. locate car spaces for unit 12 5. show note re rear courtyard space	dimensions on site prior to commencement of construction.	Site Address: Unit 12 380 Somerville Road West Footscray Clients: Mr Pavez	Project Tile: Internal Fitout of Existing Tilt Panel Building with Mezzanine for Factory	Drawing Title: GENERAL NOTES Scale: NTS	AO6	Site Orientation:	DEE'S DESIGNS ddneville DP/AD1431 Bachelor of Architecture 71 Hansen Street West Footscray 3012 phone 0416162526 email: ddneville3012@hotmail.com
	NOT FOR CONSTRUCTION			12/05/2025	Paper size: A3	DP/AD 1431	